


**CEILING LEGEND**

	METAL SOFFIT SYSTEM
	LAY-IN ACOUSTIC GRID CEILING - TYPE "A" = ACOUSTIC TILES W/ REGULAR EDGE - TYPE "B" = ACOUSTIC TILES W/ SQUARE EDGE - TYPE "C" = GYPSUM BOARD TILES
9'-0"	CEILING HEIGHT REFERENCE
EXPOSED	NO FINISHED CEILING - EXPOSED TO ROOF STRUCTURAL ABOVE
A.F.F.	ABOVE FINISH FLOOR

**CEILING NOTES:**

- COORDINATE THIS CEILING PLAN WITH THE HVAC PLAN AND LIGHTING PLAN. NOTIFY ARCHITECT OF ANY DISCREPANCIES.
- FINISH ALL EXPOSED SIDES OF DRYWALL FURR DOWNS.
- EXTEND WALLS TO BOTTOM OF ROOF PURLINS & BOTTOM FACE OF BANDED ROOF INSULATION. THIS INCLUDES LOBBY, COMMONS, CORRIDORS, DINING, AND GYMNASIUM. SEE WALL SECTIONS FOR ADDITIONAL INFORMATION.
- EXPOSED ROOF STRUCTURE TO BE PAINTED INCLUDES PAINTING ALL EXPOSED DUCTWORK, DOMESTIC PIPING, GAS PIPING, ELECTRIC CONDUIT, FIRE ALARM CONDUIT, ACOUSTIC PANELS, FIRE SPRINKLER PIPING AND MISC. DEVICES AND EQUIPMENT FOR A COMPLETE COLOR FINISH.

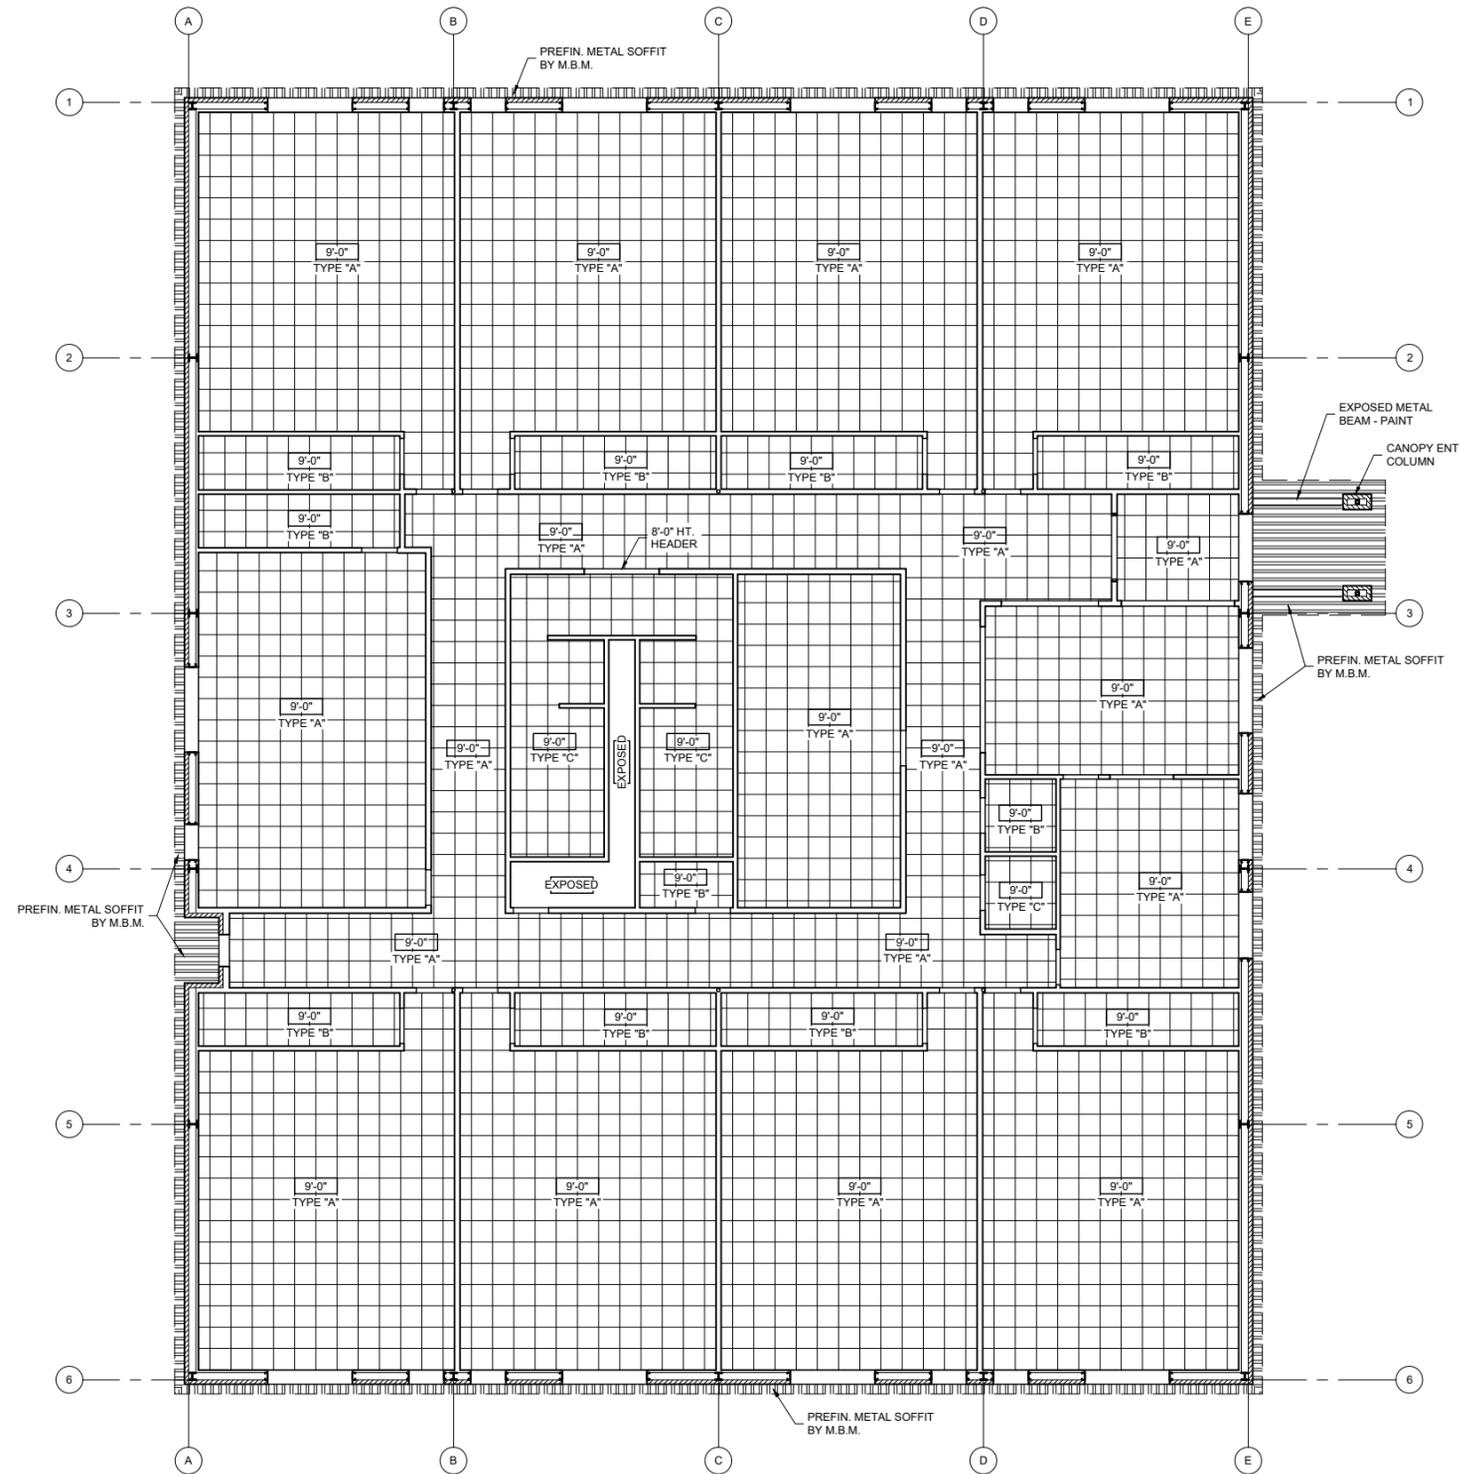

**A REFLECTED CEILING PLAN** NORTH  
 1/8" = 1'-0"

STRATFORD PUBLIC SCHOOLS  
**NEW CLASSROOM BUILDING**  
 STRATFORD, OKLAHOMA

REVISIONS:  
 DATE ISSUED:  
 November 4, 2025  
 PROJECT NUMBER:  
 ---  
 SHEET DESCRIPTION:  
 REFLECTED  
 CEILING PLAN  
 SHEET NUMBER:

**A301**